

RE: S0-1 & S0-2 FOR
FOUNDATION NOTES
& SCHEDULE

PLEASE REVIEW
ARCHITECTURAL DRGS.
FOR SLOPES DROPS &
DEPRESSIONS.

SLAB NOTE
 *4" THICK CONCRETE SLAB (UNLESS NOTED OTHERWISE)
 ON MINIMUM TEN(10) MIL VAPOR BARRIER ON COMPACTED
 FILL SUBGRADE. THE VAPOR BARRIER SHALL CONFORM TO
 ASTM E1745 CLASS A OR BETTER AND SHALL HAVE A
 MAXIMUM WATER VAPOR PERMEANCE OF 0.01 PERMS
 WHEN TESTED IN ACCORDANCE WITH ASTM E96.
 THE VAPOR BARRIER SHALL BE INSTALLED PER THE
 MANUFACTURER'S RECOMMENDATIONS AND ASTM E1643,
 STANDARD PRACTICE FOR INSTALLATION OF WATER VAPOR
 BARRIERS USED IN CONTACT WITH EARTH OR GRANULAR
 FILL UNDER CONCRETE SLABS. REFER TO GEOTECHNICAL
 REPORT FOR SUBGRADE PREPARATION AND COMPACTION
 REQUIREMENTS.

GRADE BEAM SCHEDULE

PLAN MARK	PLAN SYM.	BEAM WIDTH	BEAM DEPTH	NOTES
THICKENED SLAB	RE: PLAN	12"	12"	2-#6 BOT.
REINF. BEAM	RB	12"	30"	2-#5 BOT. w/#3 TIES@EACH TENDON
GRADE BEAM	---	12"	30"	1 TENDON

1 FOUNDATION PLAN - CLUB
SCALE: 1/8"=1'-0"

Sheet Title: ROOF FRAMING AND SHEARWALL PLAN - CLUB

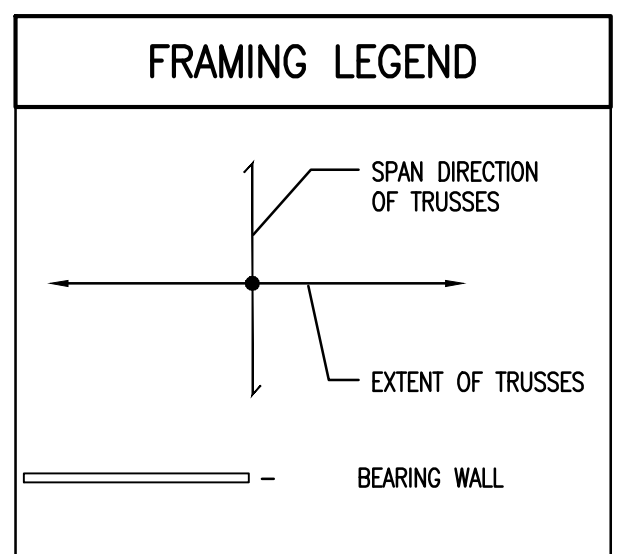
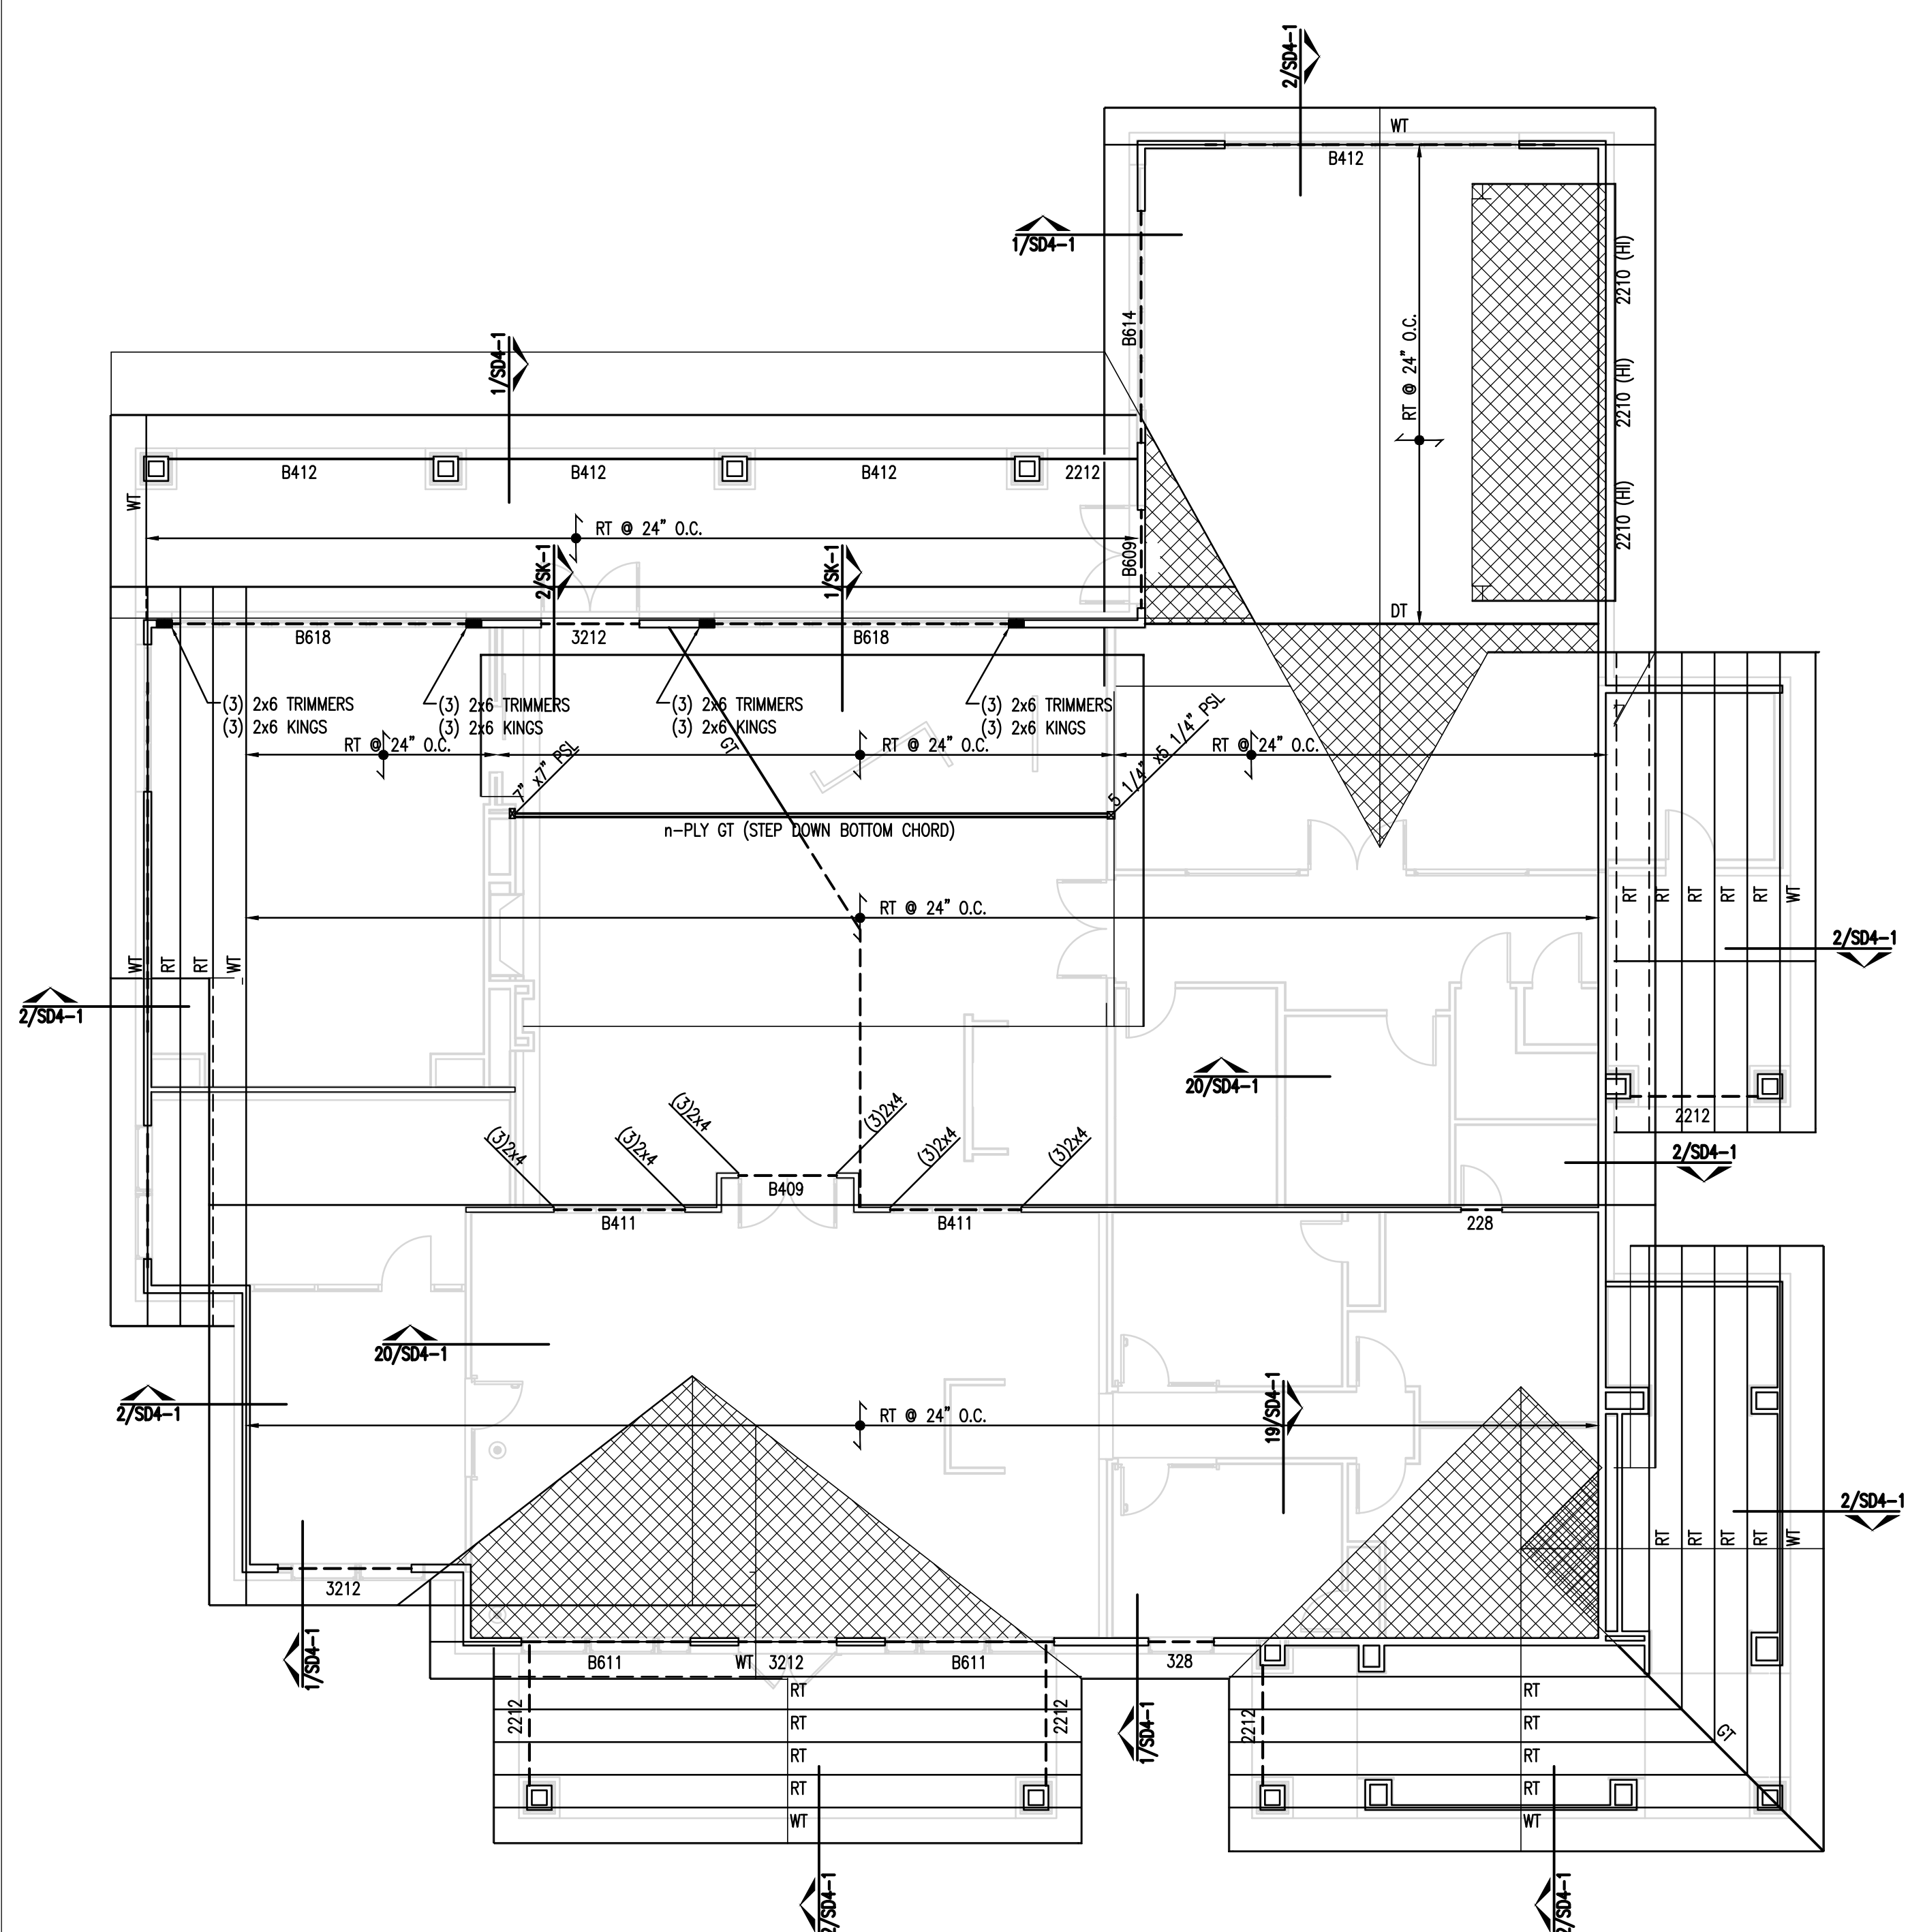
Revision	Description	Date
1		9/22/15

Drawn By: MJS	Checked By: ZA
Drawing Scale: As Noted	Project No. 1304-016
ISSUED FOR:	DATE:
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<input type="checkbox"/> CD 60%	
<input type="checkbox"/> CD 95%	
<input type="checkbox"/> CD 100%	
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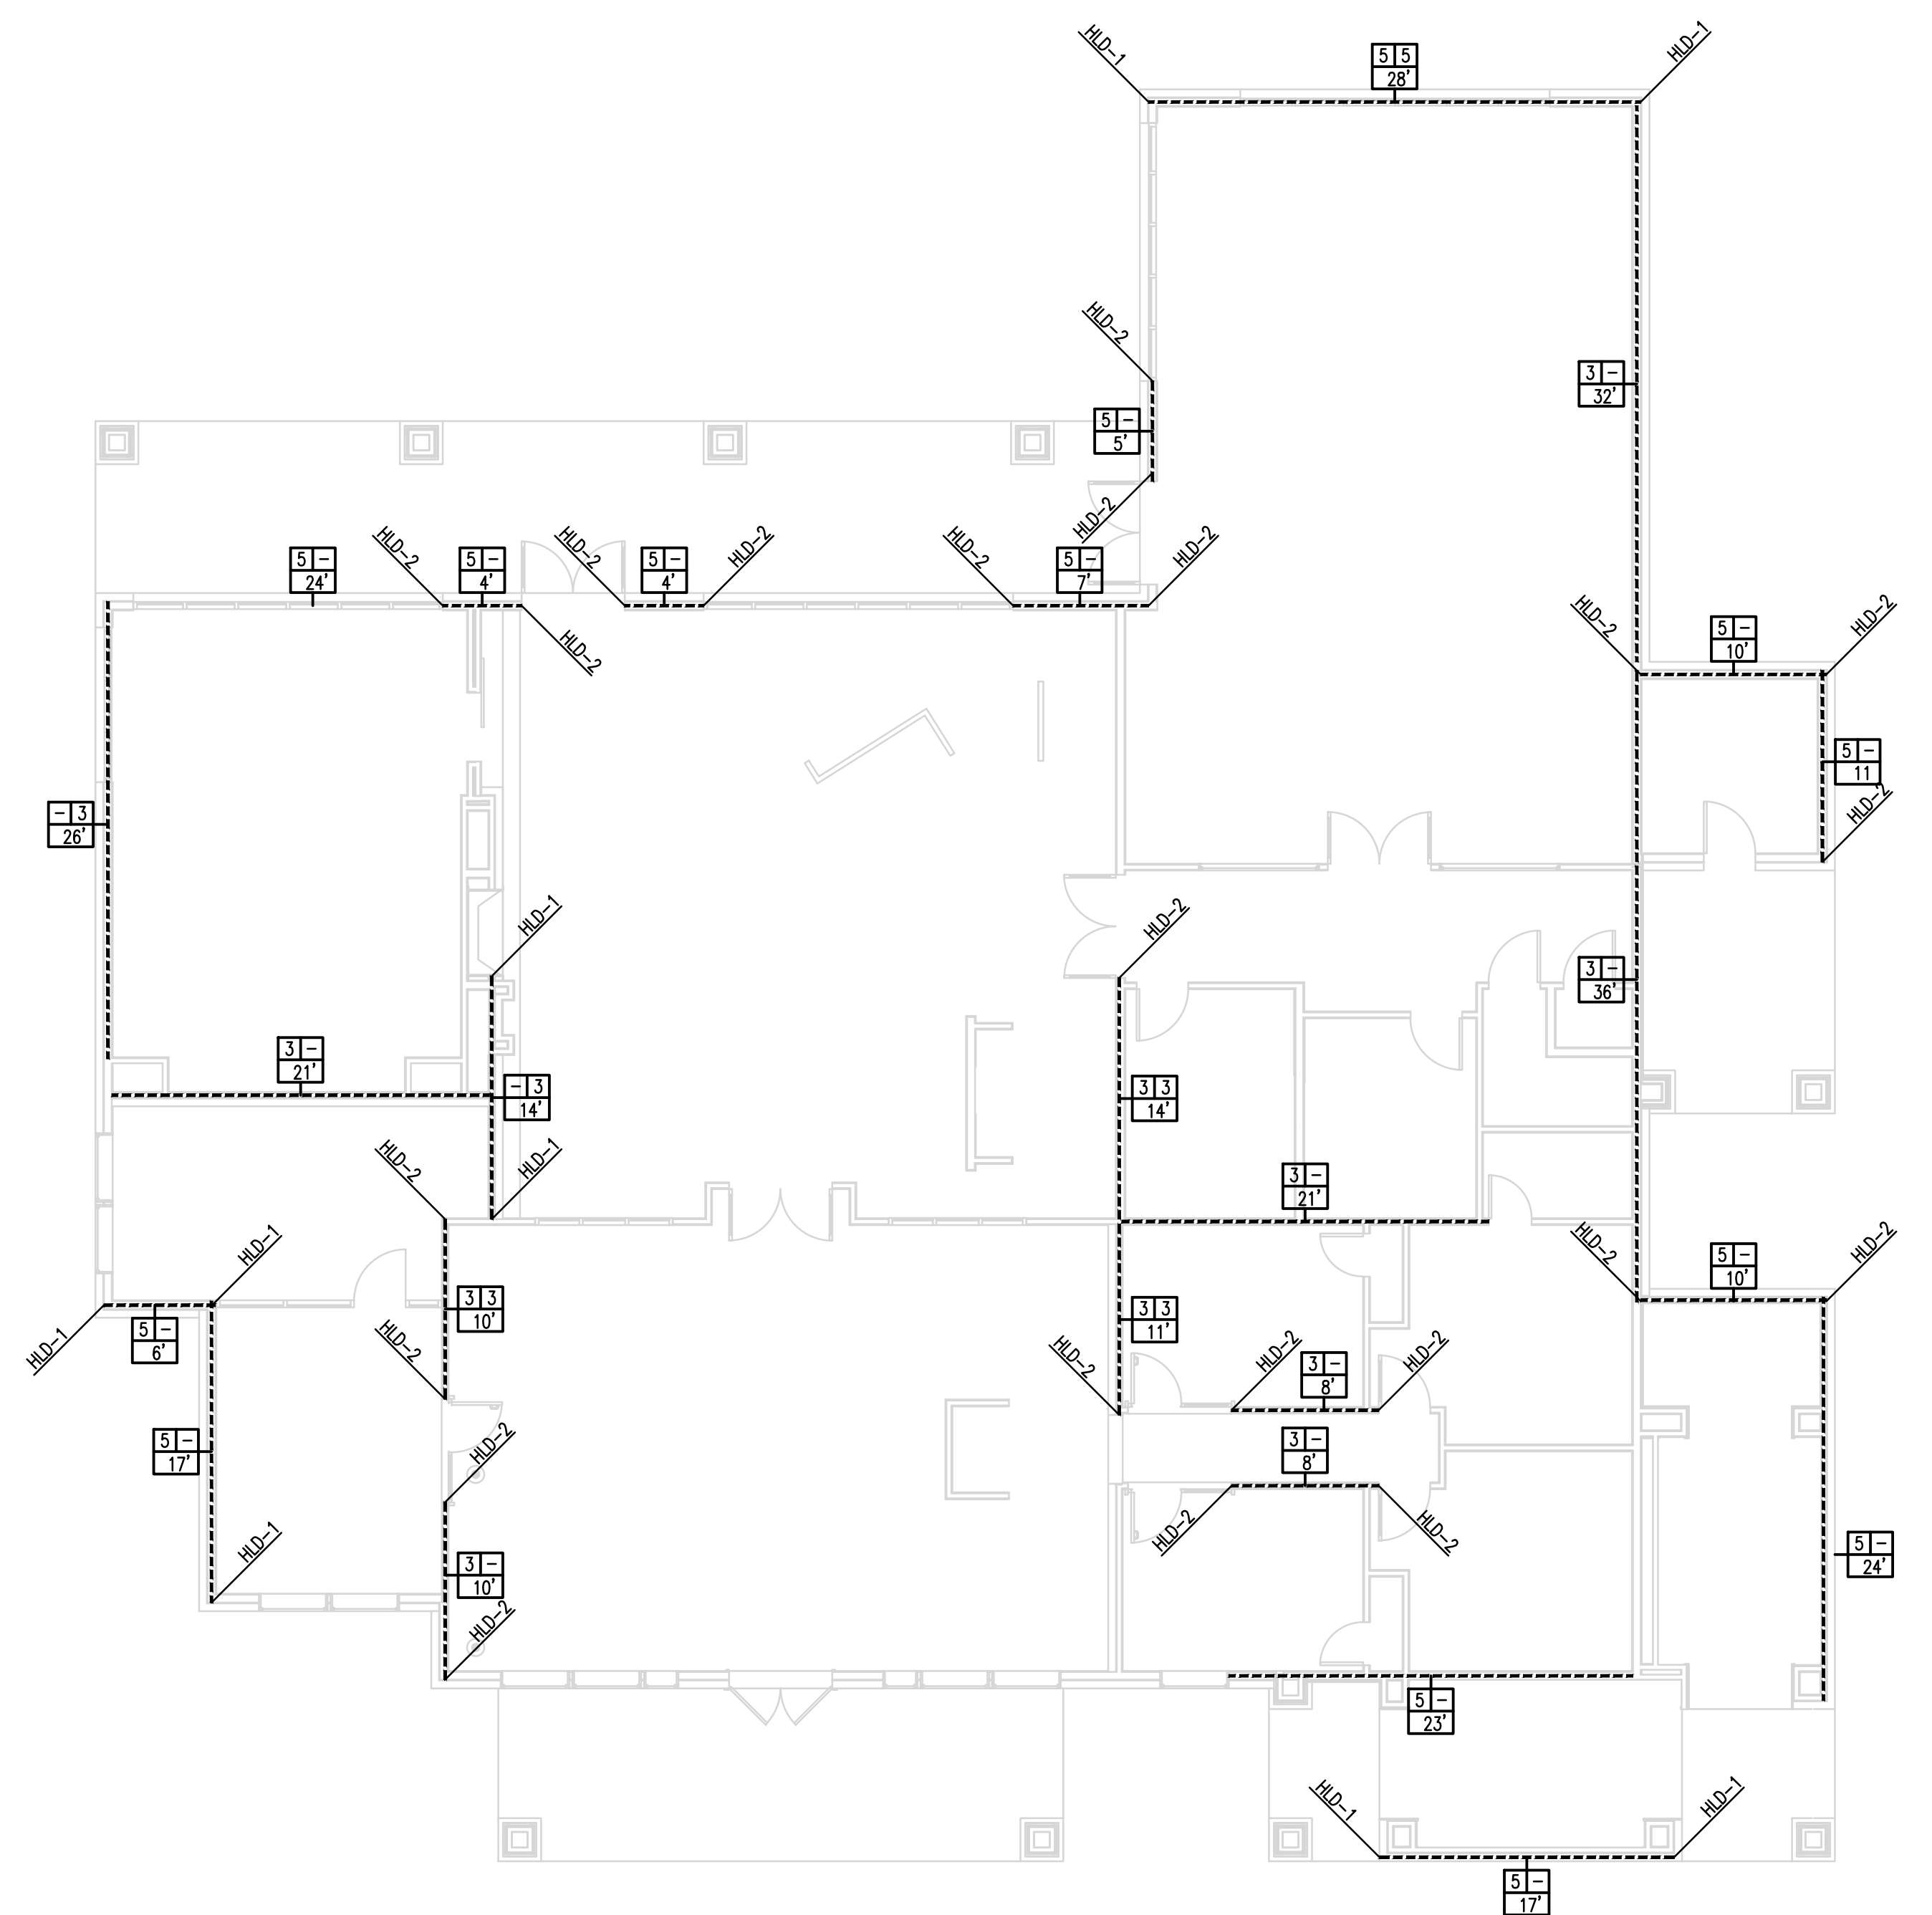
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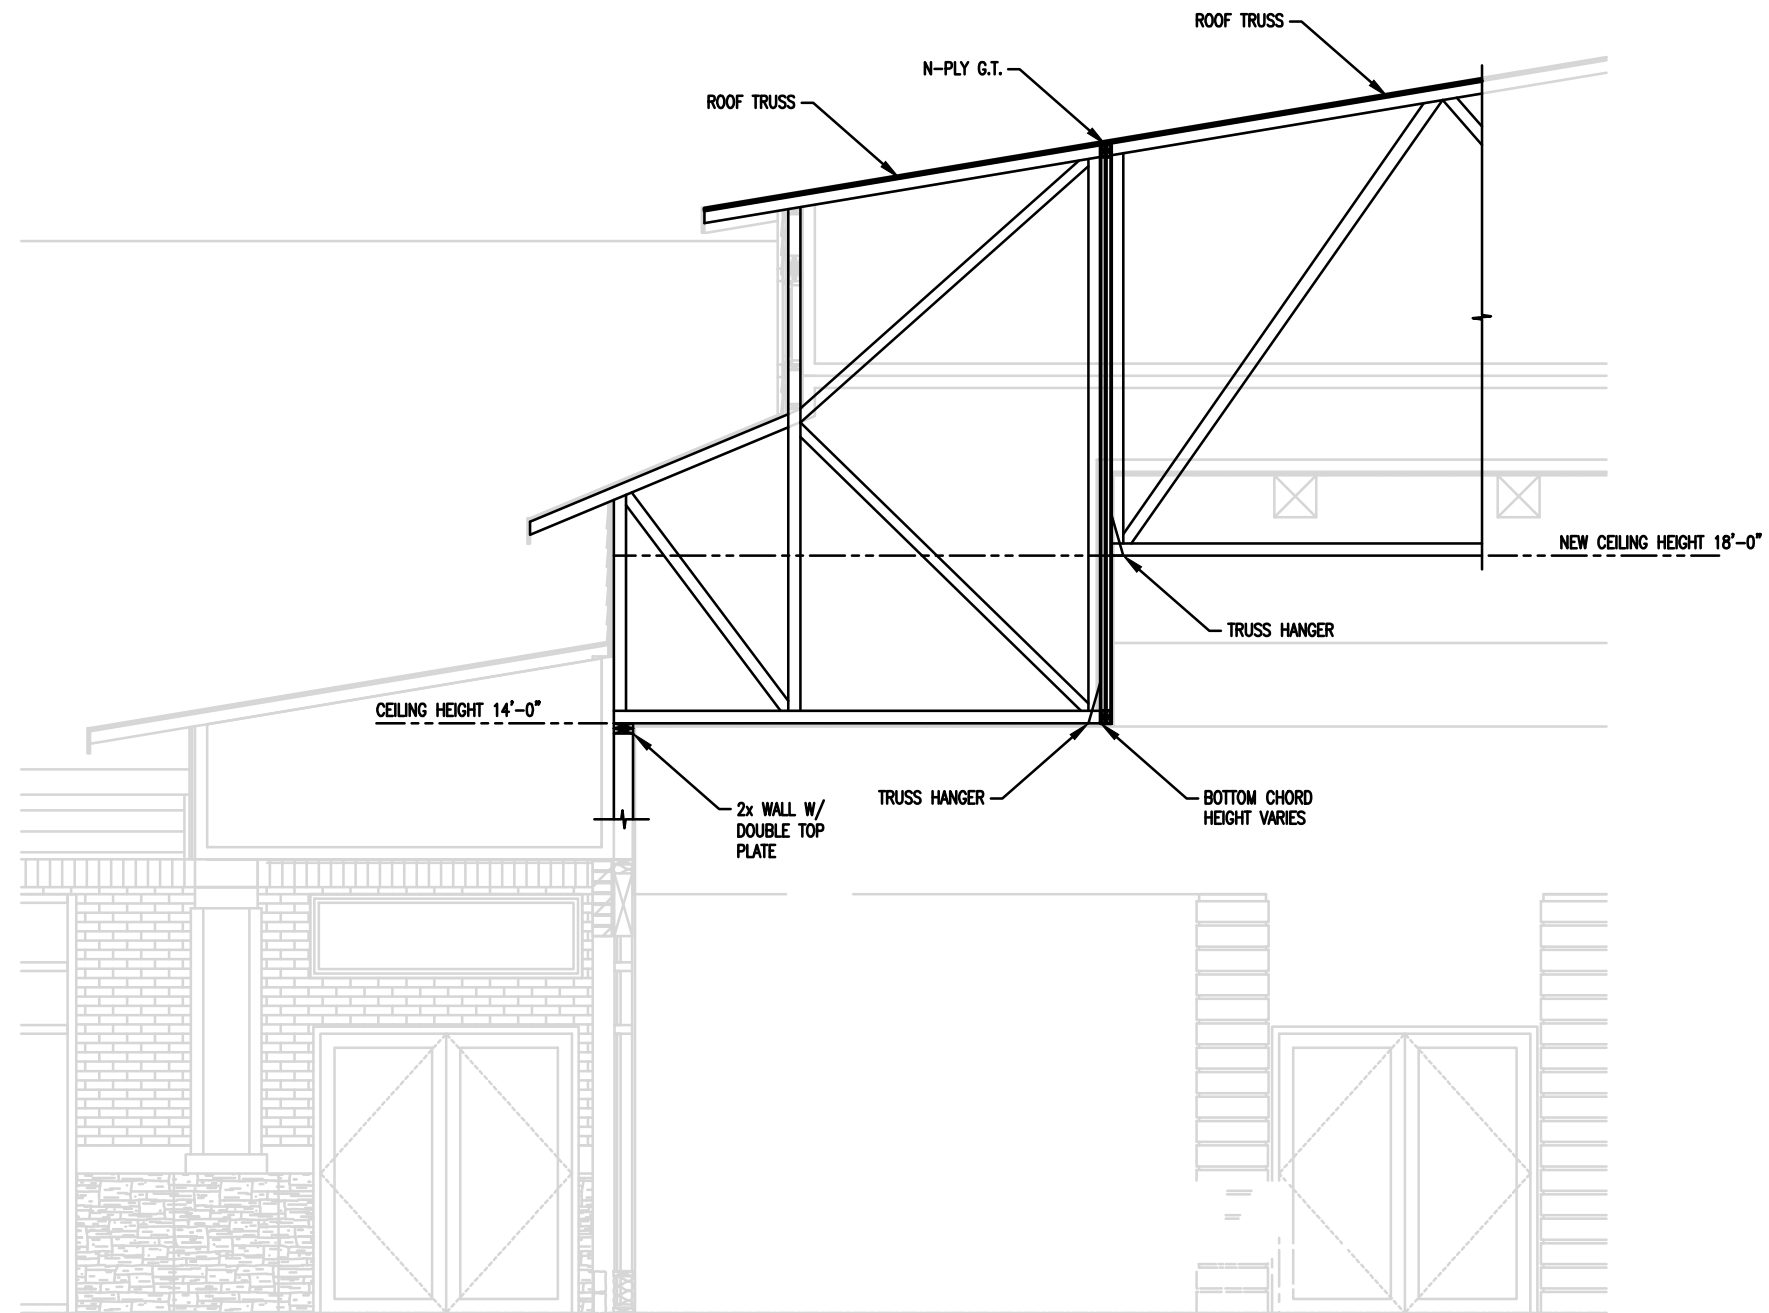
RE: SO-1, SO-3 & SO-5
FOR FRAMING NOTES
AND SCHEDULE



2 SHEARWALL PLAN - CLUB
SCALE: 1/8"=1'-0"

RE: SO-1, SO-3 & SO-5
FOR SHEARWALL NOTES
AND SCHEDULE

1 ROOF FRAMING PLAN - CLUB
SCALE: 1/8"=1'-0"



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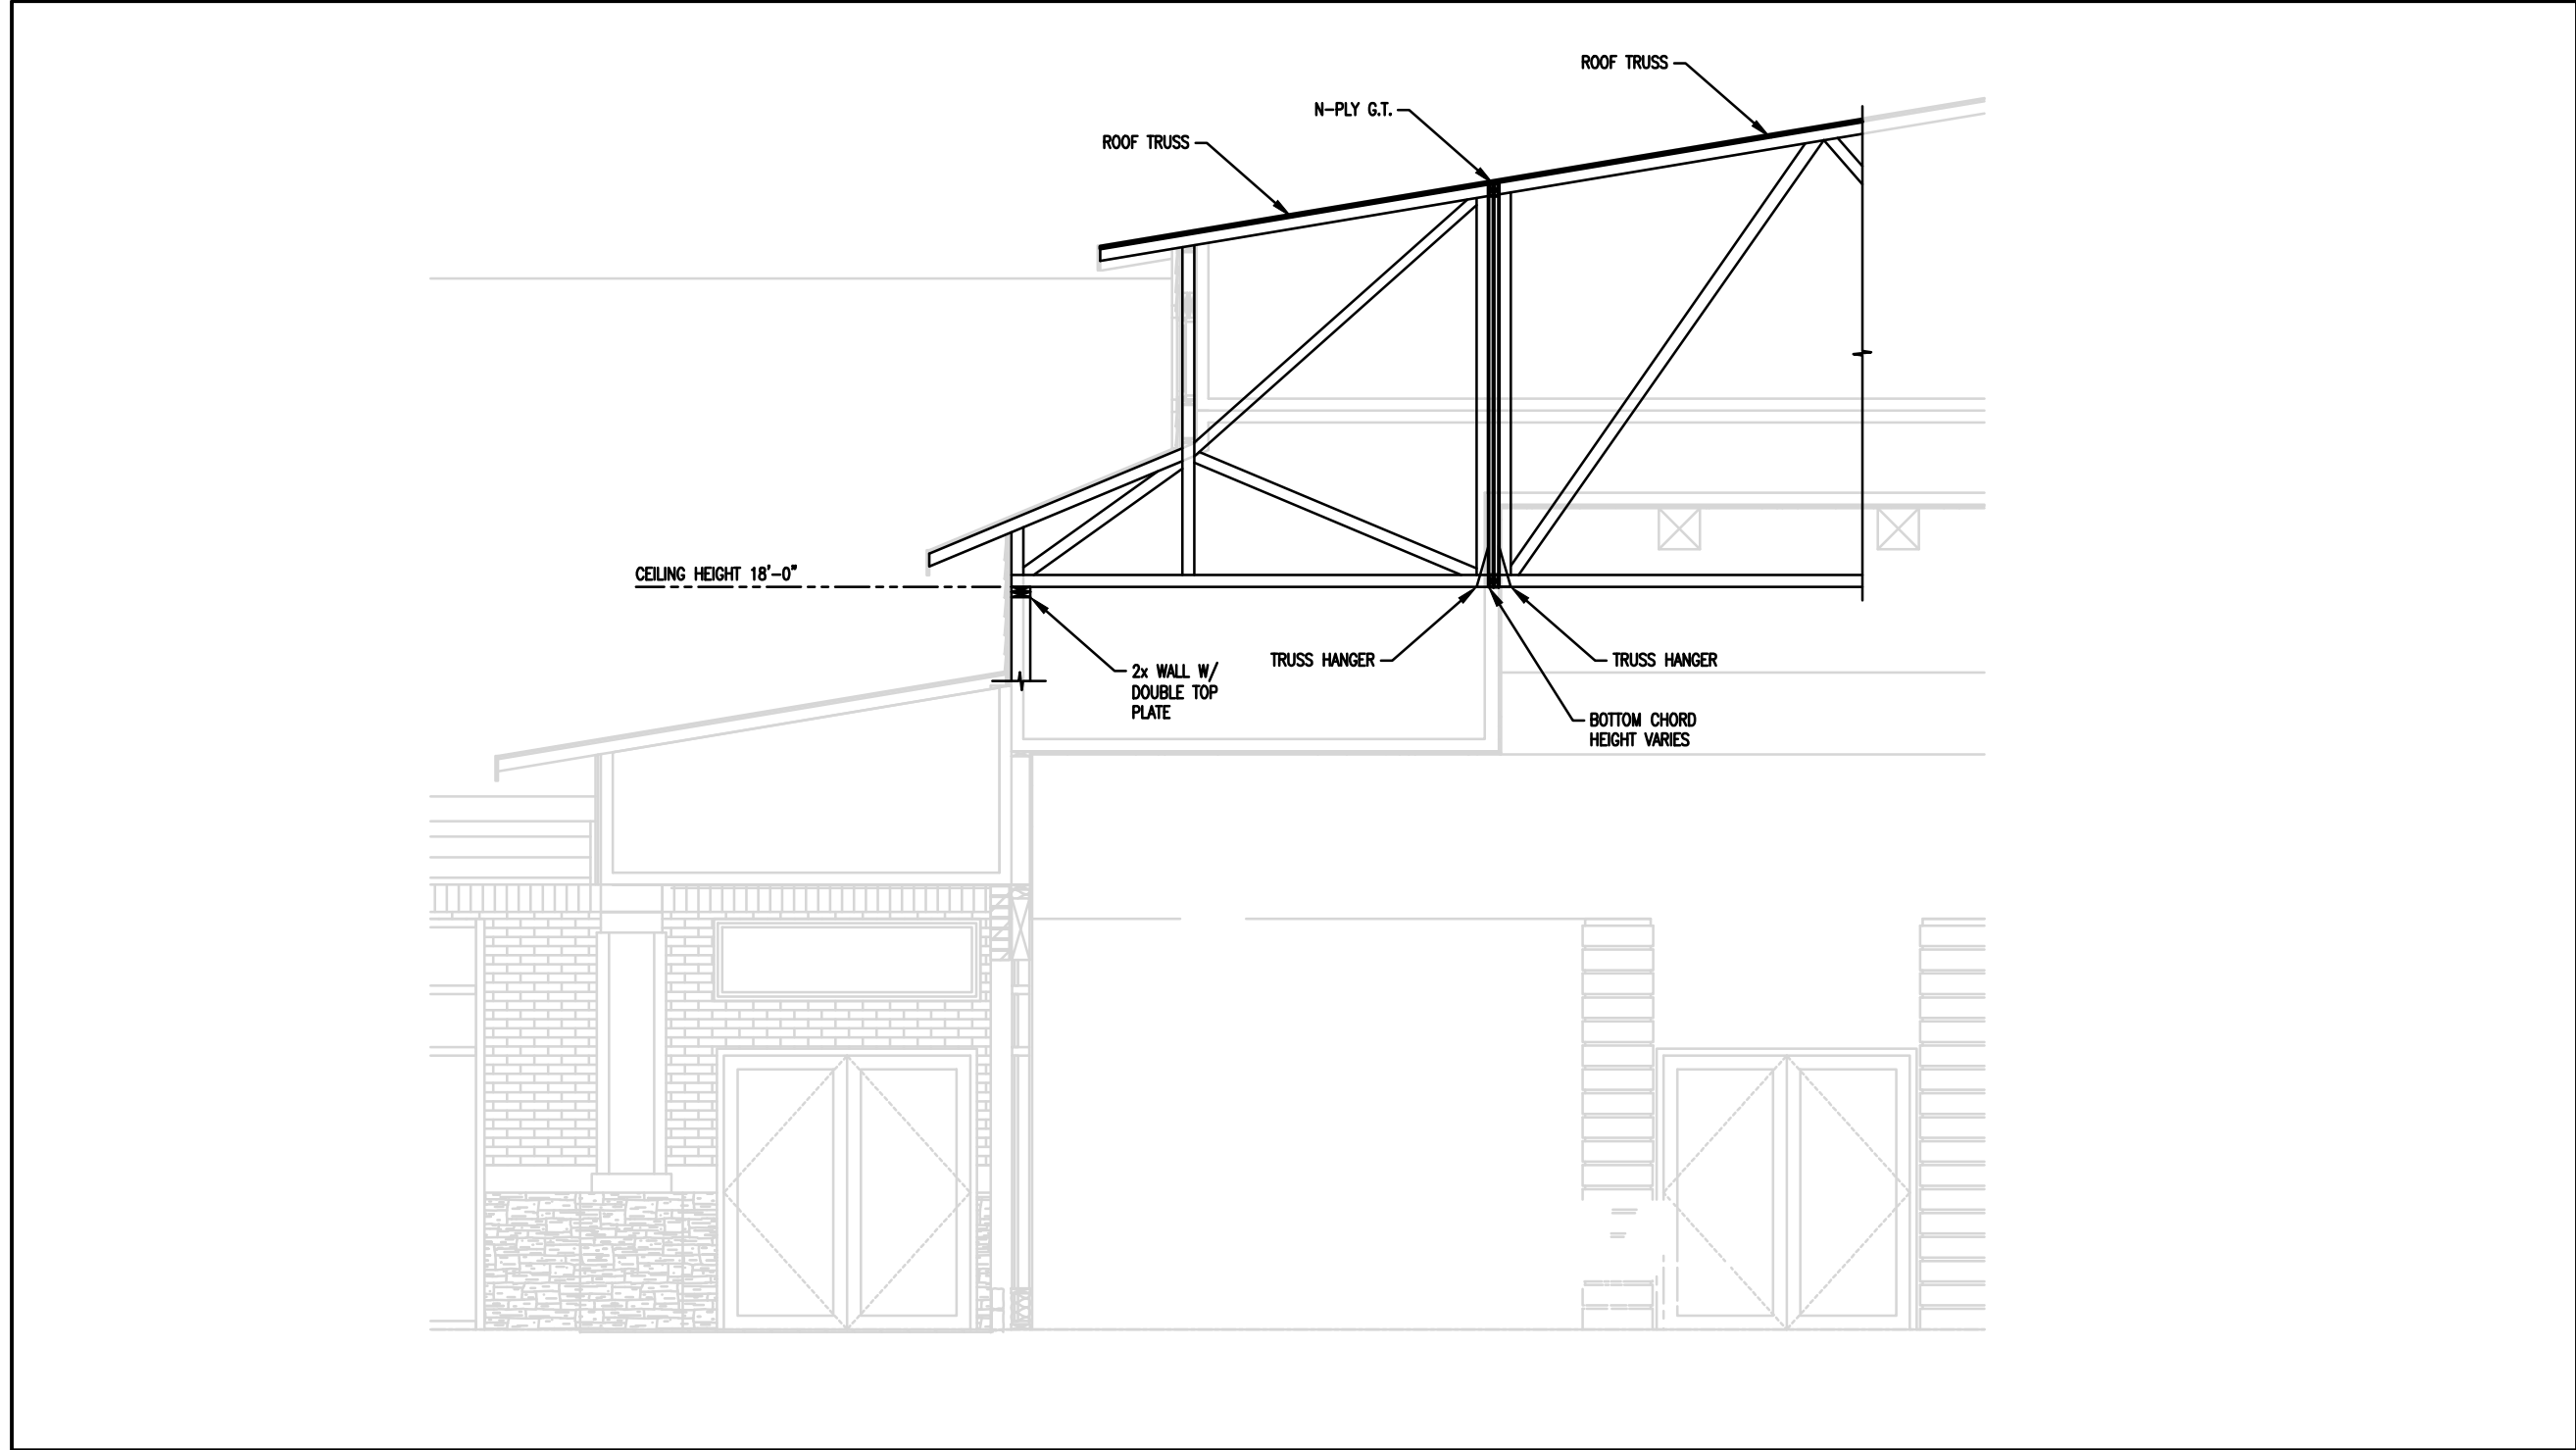
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**KINGSLAND APARTMENTS
HOUSTON, TEXAS
A DEVELOPMENT BY: ODEN HUGHES
ARCHITECTURE BY: KELLY GROSSMAN ARCHITECTS
ROOF TRUSS SECTION**


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SHEET NO.
DRAWING NO.

SK-1



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ROOF TRUSS SECTION**

PROJECT NO.	1304-016
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SHEET NO.
SK-2